
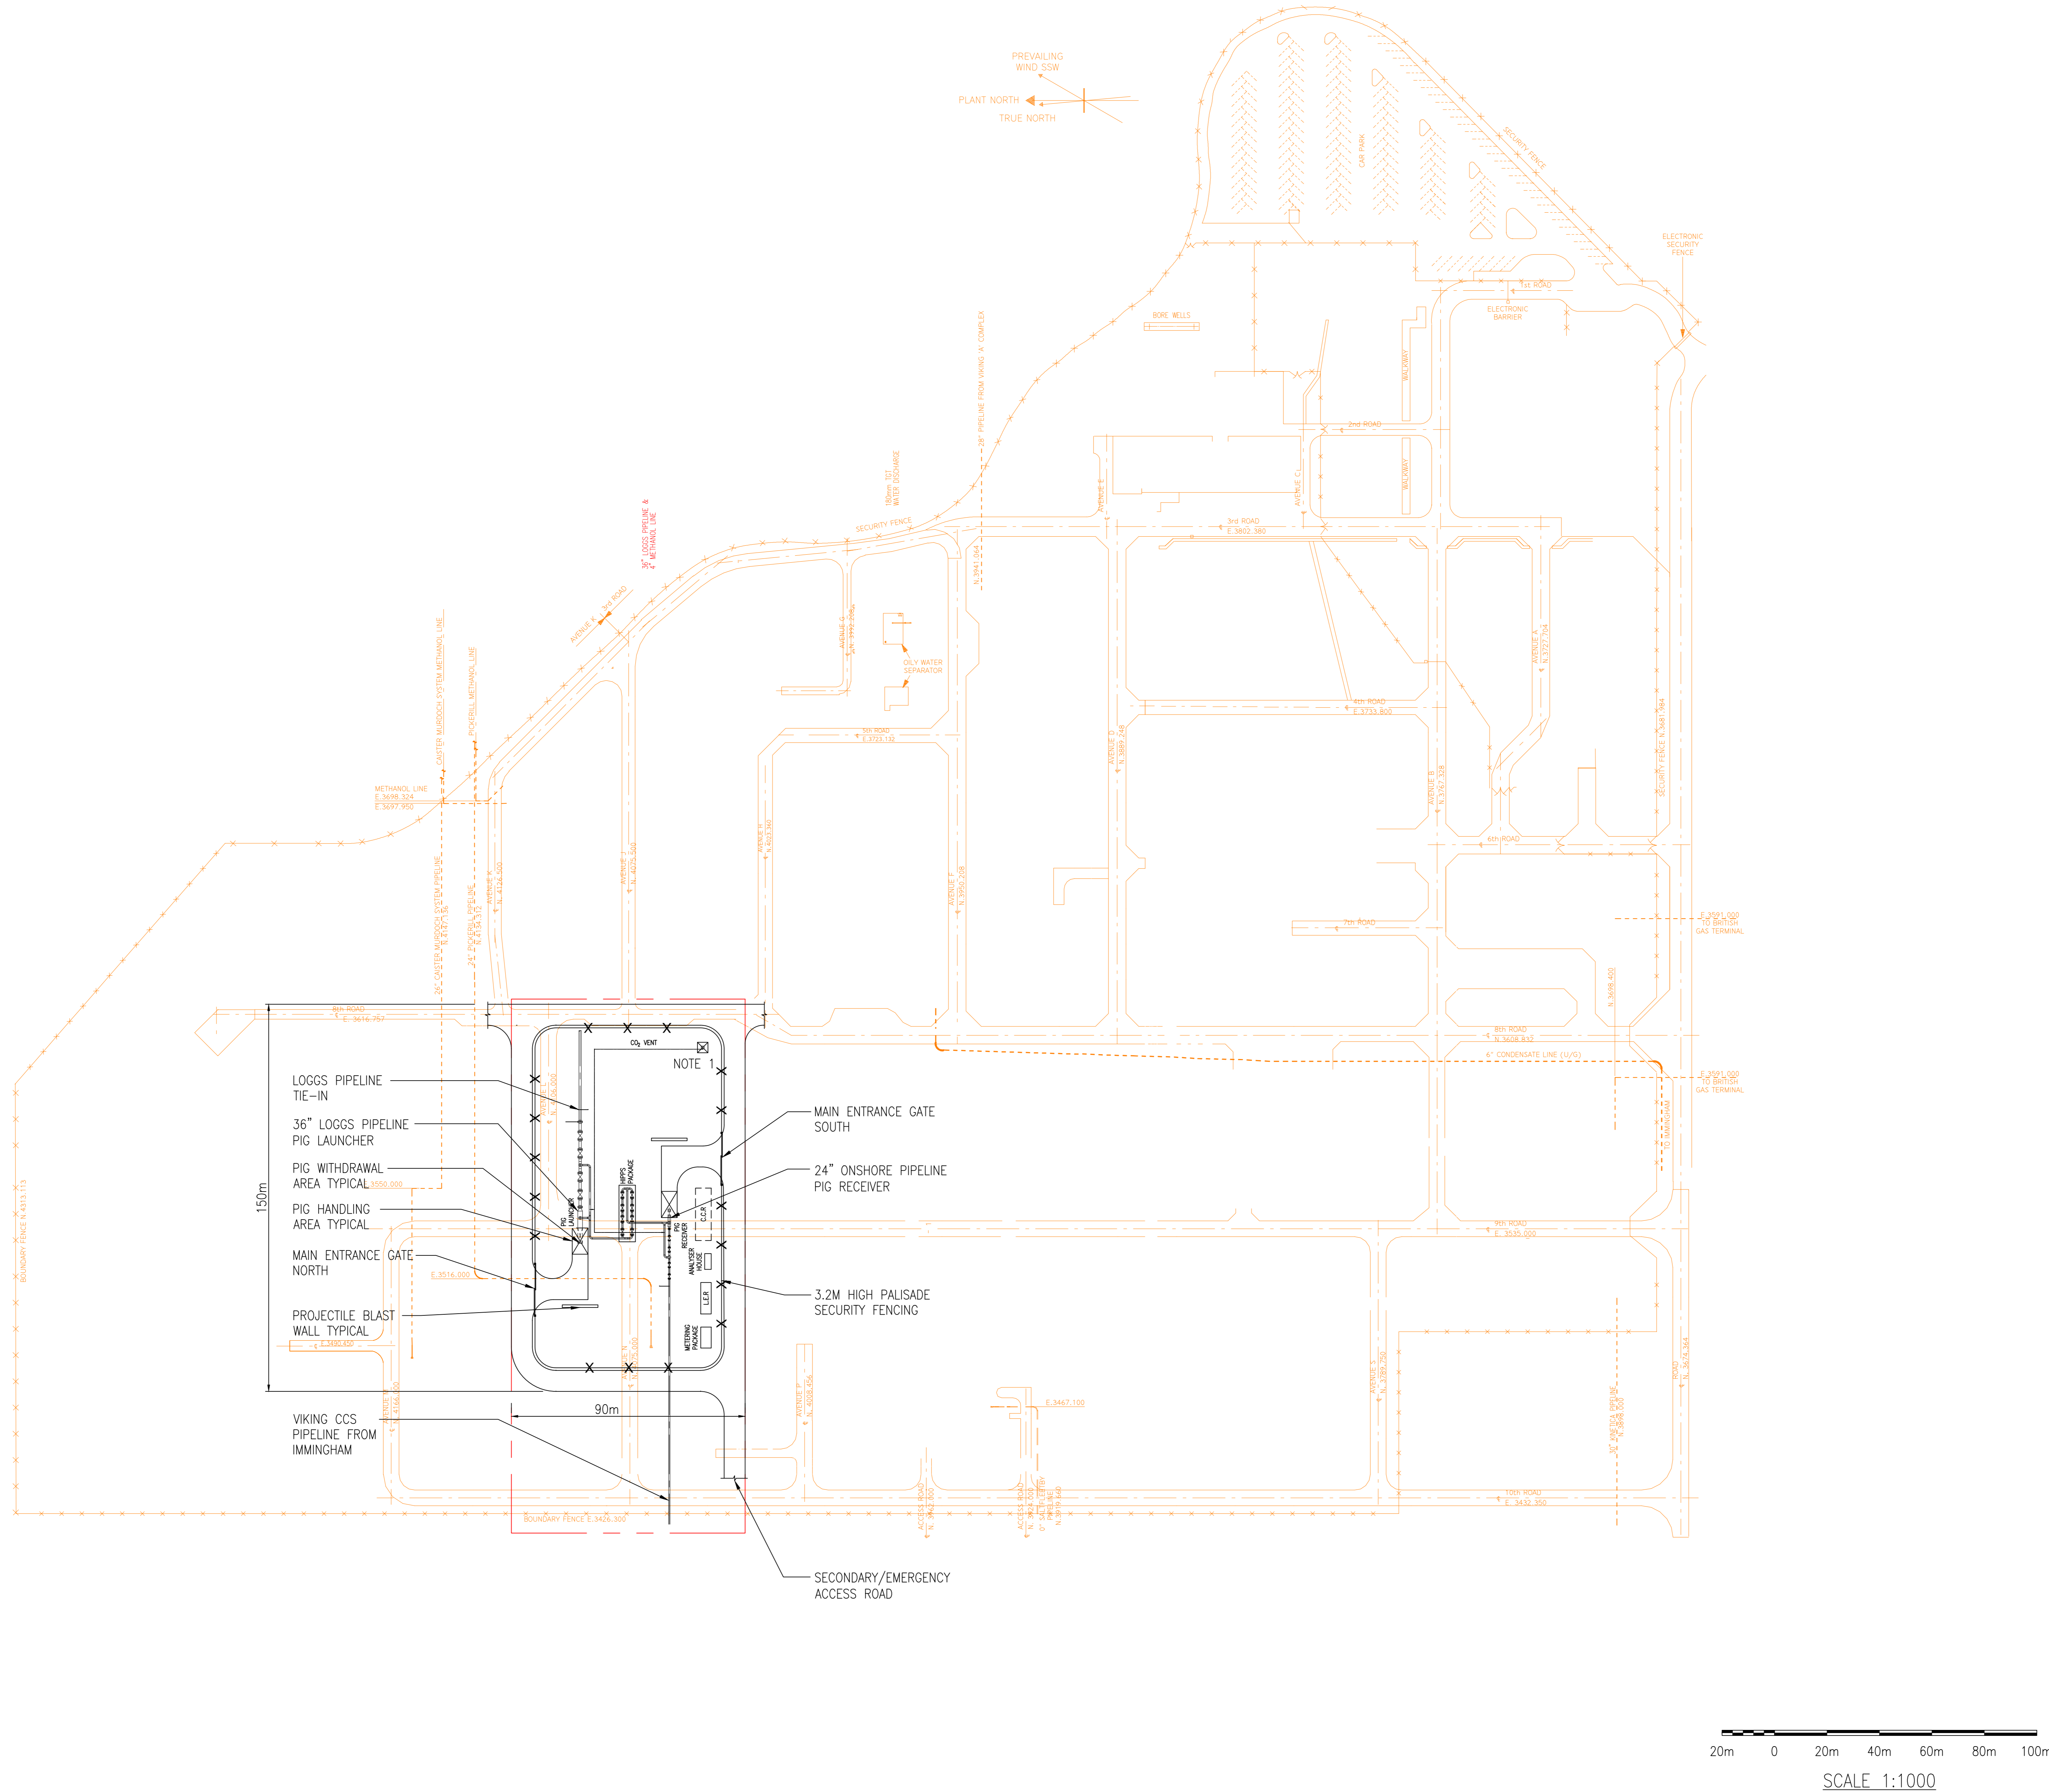


Viking CCS pipeline

## 4.7 Theddlethorpe Facilities Option 1, Plot Plan, Routing and Elevations

Document Reference: EN070008/APP/4.7

Applicant: Chrysaor Production (U.K.) Limited,  
a Harbour Energy Company  
PINS Reference: EN070008  
Planning Act 2008 (as amended)  
The Infrastructure Planning (Applications: Prescribed Forms  
and Procedure) Regulations 2009 - Regulation 5(2)(o)  
Date: October 2023

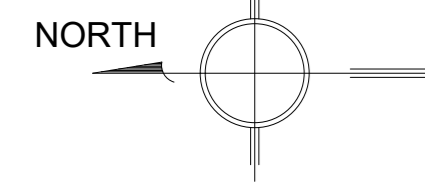

- NOTES:**
1. VENT STACK OPEN END TERMINATION ELEVATION = +25.0M ABOVE GRADE-NB. THE VENT WILL ONLY BE RAISED WHEN REQUIRED.
  2. EXISTING SITE ROADS SHOWN IN ORANGE.
  3. LER = LOCAL EQUIPMENT ROOM  
 CCR = CENTRAL CONTROL ROOM  
 HIPPS = HIGH INTEGRITY PRESSURE PROTECTION SYSTEM

REV.	DATE	REVISION DESCRIPTION	ORIG'D	CHK'D	REV'D	APP'D
A3	12/07/2023	RE-ISSUED FOR USE	RM	SG	PH	PH
A2	02/06/2023	RE-ISSUED FOR USE	JB	SG	PH	PH
A1	11/11/2022	ISSUED FOR USE	JB	SG	PH	PH
A0	19/05/2022	ISSUED FOR IDC	JB	SG	PH	PH



SCALE: 1:1000 ORIGINAL DRAWING SIZE: A0



PROJECT: VIKING CCS PIPELINE FEL-2

TITLE: THE THEDDLETHORPE FACILITY PLOT PLAN

DCO APPLICATION DETAILS:  
 VIKING CCS PIPELINE  
 THEDDLETHORPE FACILITIES - PLOT PLAN  
 REGULATION 5.2 (O)  
 APPLICATION DOCUMENT REFERENCE 4.7  
 SHEET 1 OF 3

CLIENT DRAWING NUMBER: KNT-UKOS-T-TGT-X-EN-30-00002-00 Rev C3  
 KENT DRAWING NUMBER: 5211584-PI-PLP-002-02  
 REV: A3

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- NOTES:**
- VENT STACK OPEN END TERMINATION ELEVATION = +25.0M ABOVE GRADE-NB. THE VENT WILL ONLY BE RAISED WHEN REQUIRED.
  - LER = LOCAL EQUIPMENT ROOM  
CCR = CENTRAL CONTROL ROOM  
HPPS = HIGH INTEGRITY PRESSURE PROTECTION SYSTEM
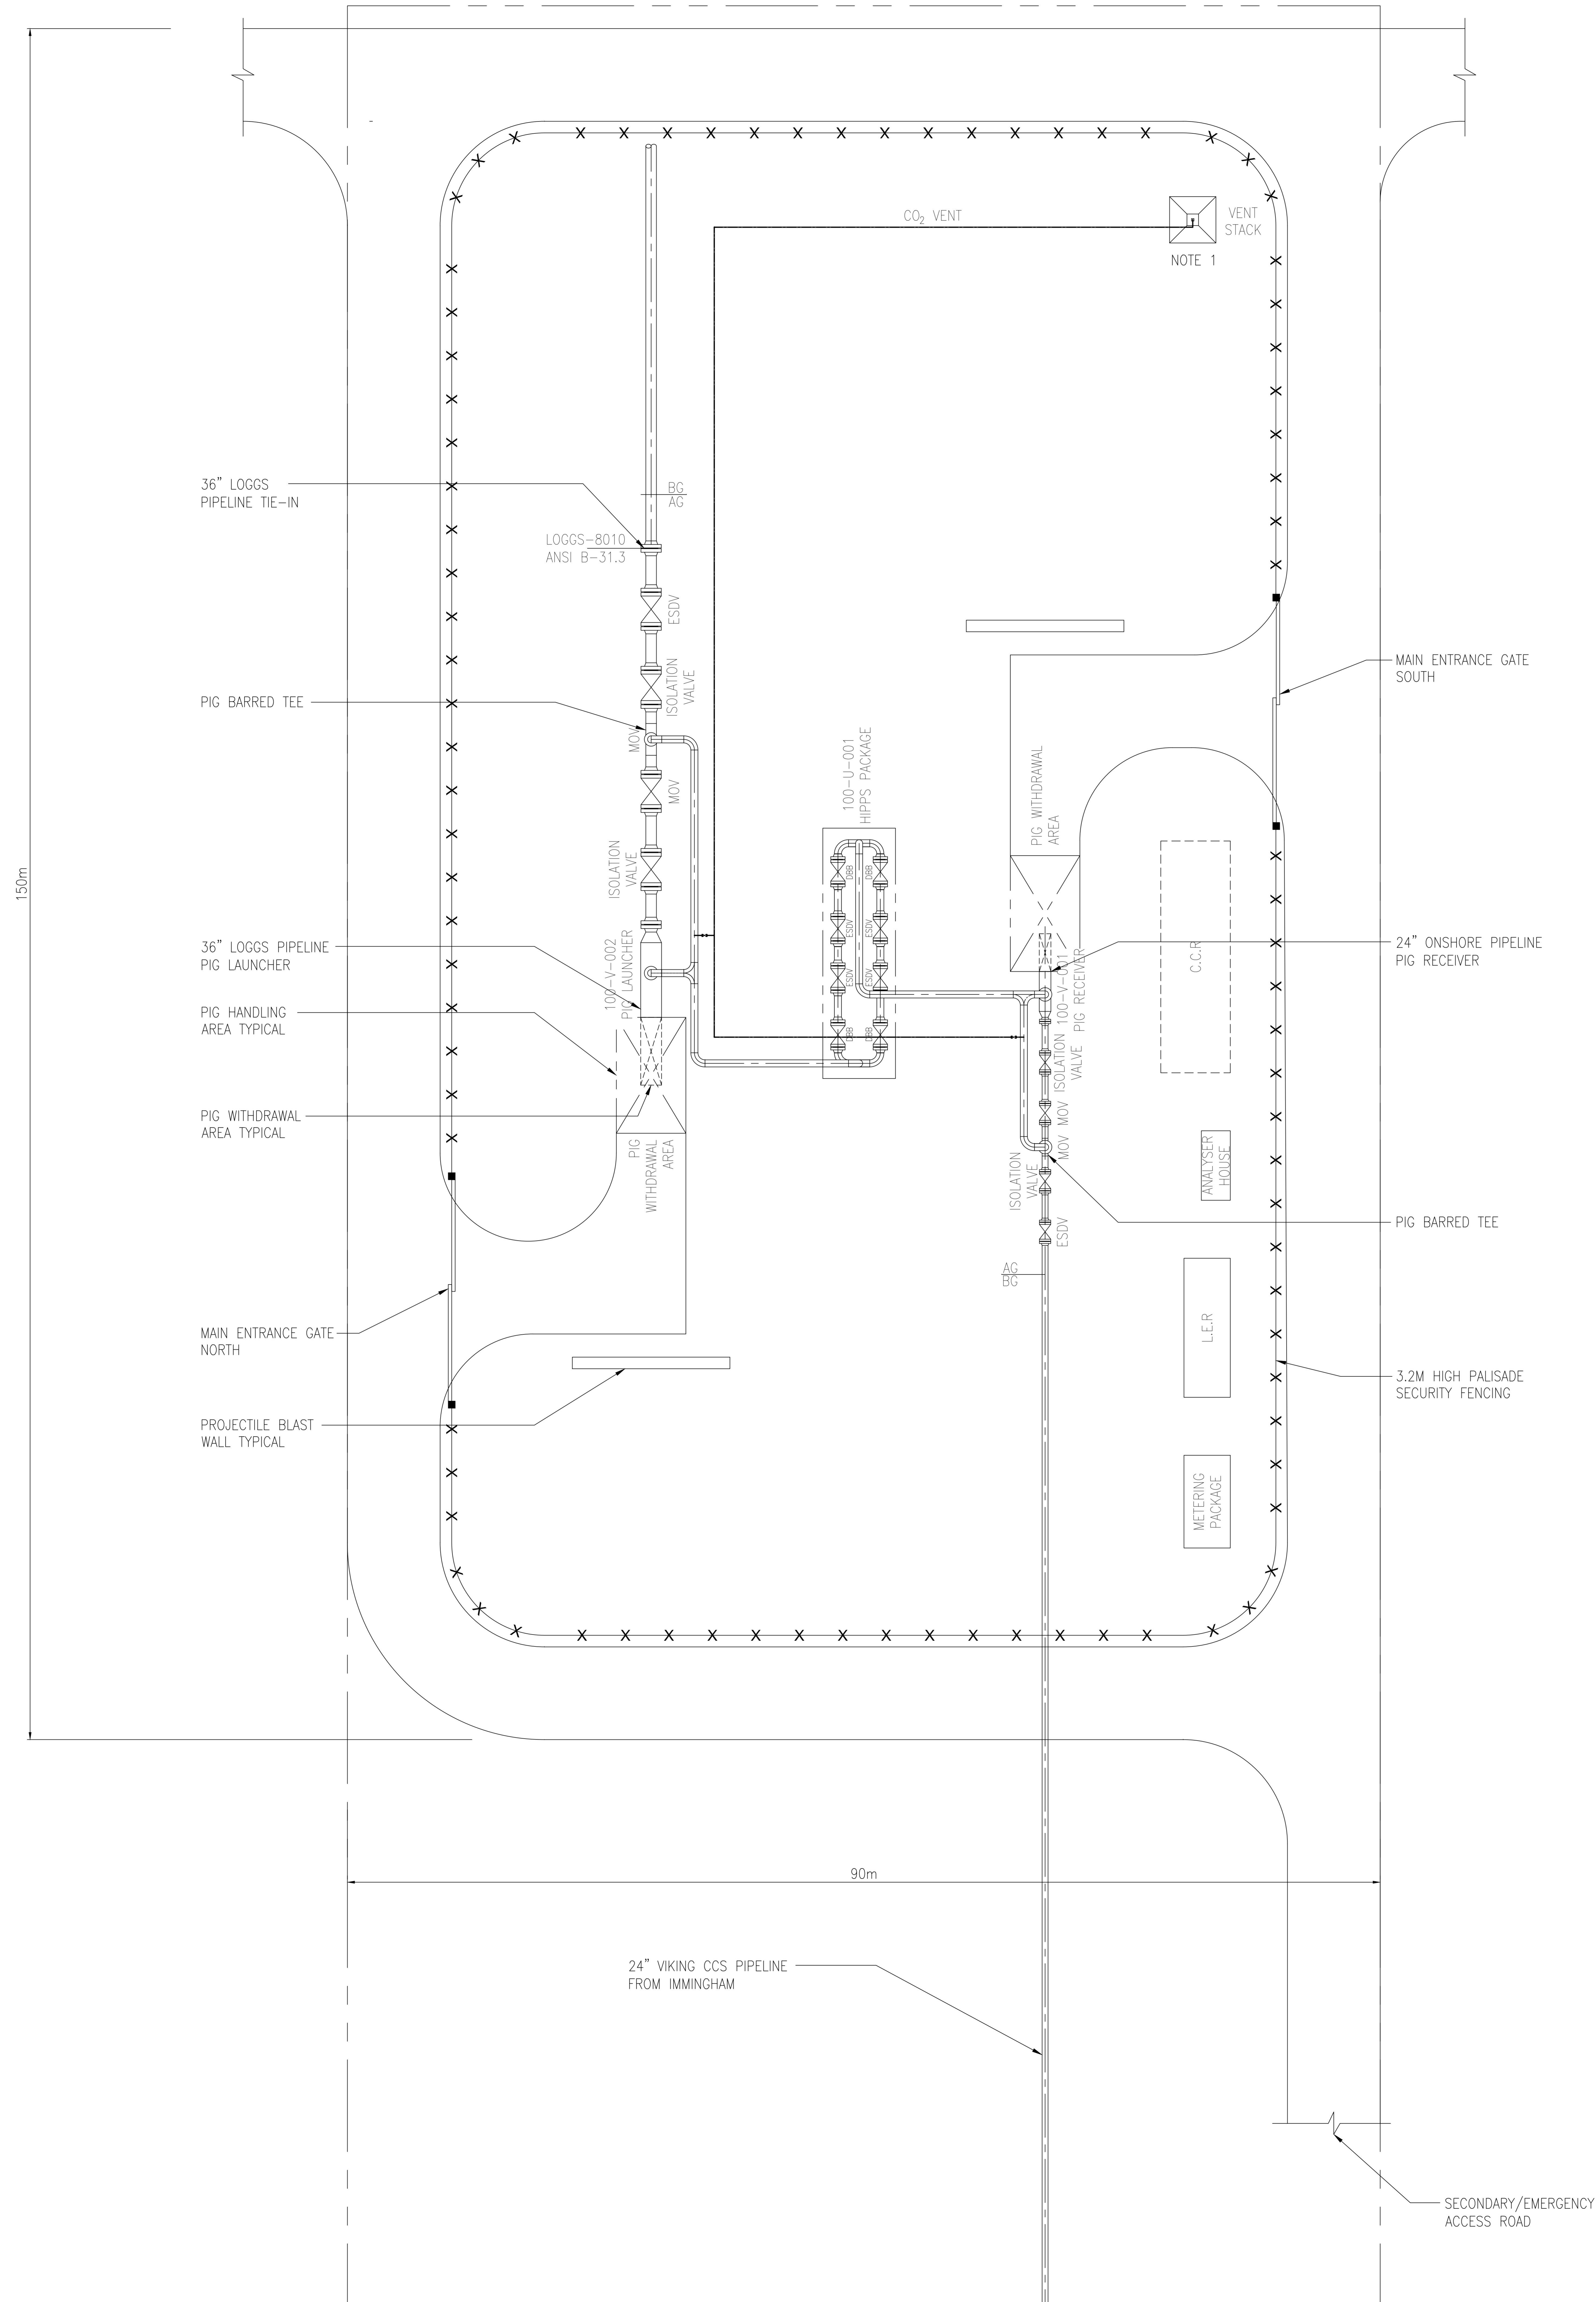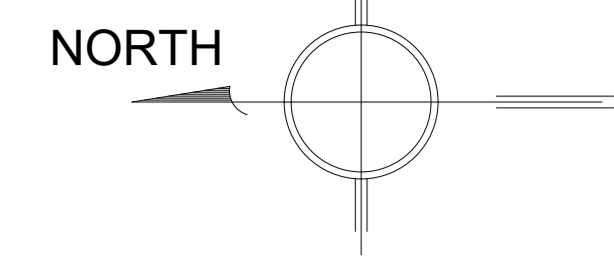
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REV.	DATE	REVISION DESCRIPTION	ORIG'D	CHK'D	REV'D	APP'D
A4	12/07/2023	RE-ISSUED FOR USE	RM	SG	PH	PH
A3	02/06/2023	RE-ISSUED FOR USE	JB	SG	PH	PH
A2	11/11/2022	ISSUED FOR USE	JB	SG	PH	PH
A1	19/05/2022	ISSUED FOR LAYOUT REVIEW	JB	SG	PH	PH
A0	19/05/2022	ISSUED FOR IDC	JB	SG	PH	PH



SCALE: 1:250 ORIGINAL DRAWING SIZE: A0


PROJECT: VIKING CCS PIPELINE FEL-2

TITLE: THE THEDDLETHORPE FACILITY PIPE ROUTING DRAWING

DCO APPLICATION DETAILS:  
VIKING CCS PIPELINE  
THEDDLETHORPE FACILITIES - PIPE ROUTING  
REGULATION 5.2 (O)  
APPLICATION DOCUMENT REFERENCE 4.7  
SHEET 2 OF 3


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KENT DRAWING NUMBER: 5211584-PI-DWG-002-02 REV A4

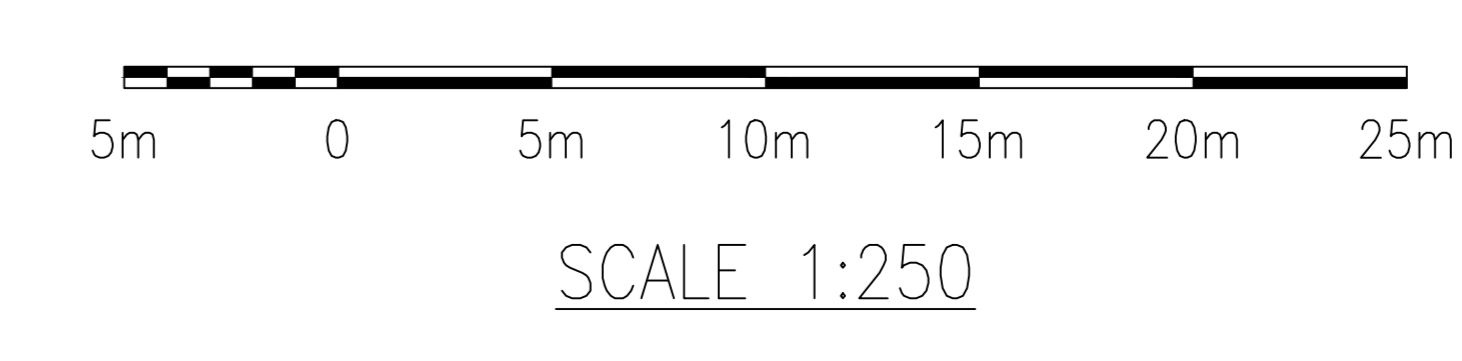


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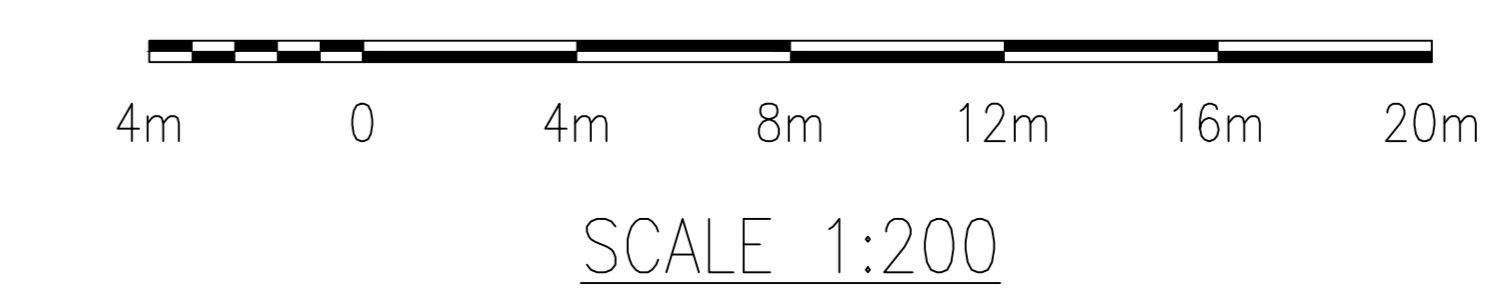
1. VENT STACK OPEN END TERMINATION ELEVATION = +25.0M ABOVE GRADE-NB. THE VENT WILL ONLY BE RAISED WHEN REQUIRED.
2. LER = LOCAL EQUIPMENT ROOM  
CCR = CENTRAL CONTROL ROOM  
HIPPS = HIGH INTEGRITY PRESSURE PROTECTION SYSTEM



ELEVATION LOOKING NORTH

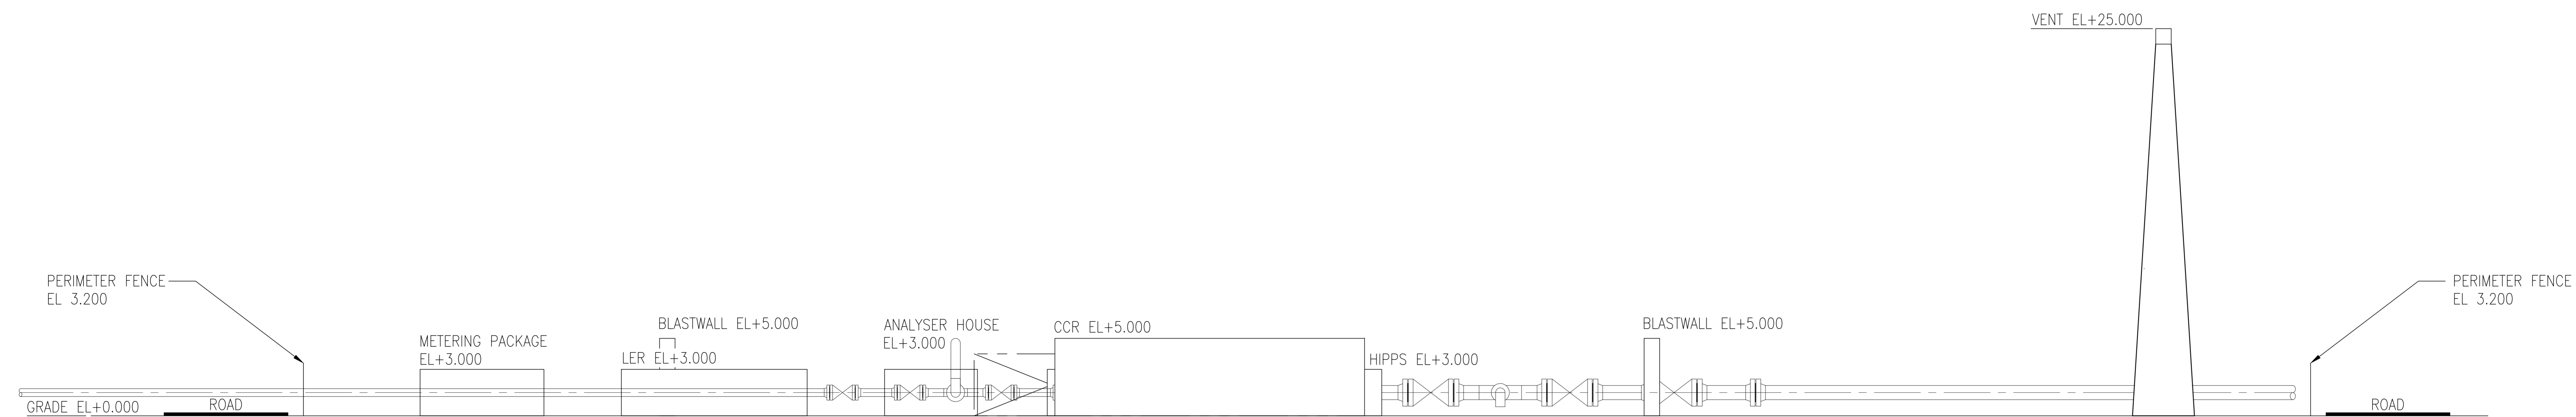

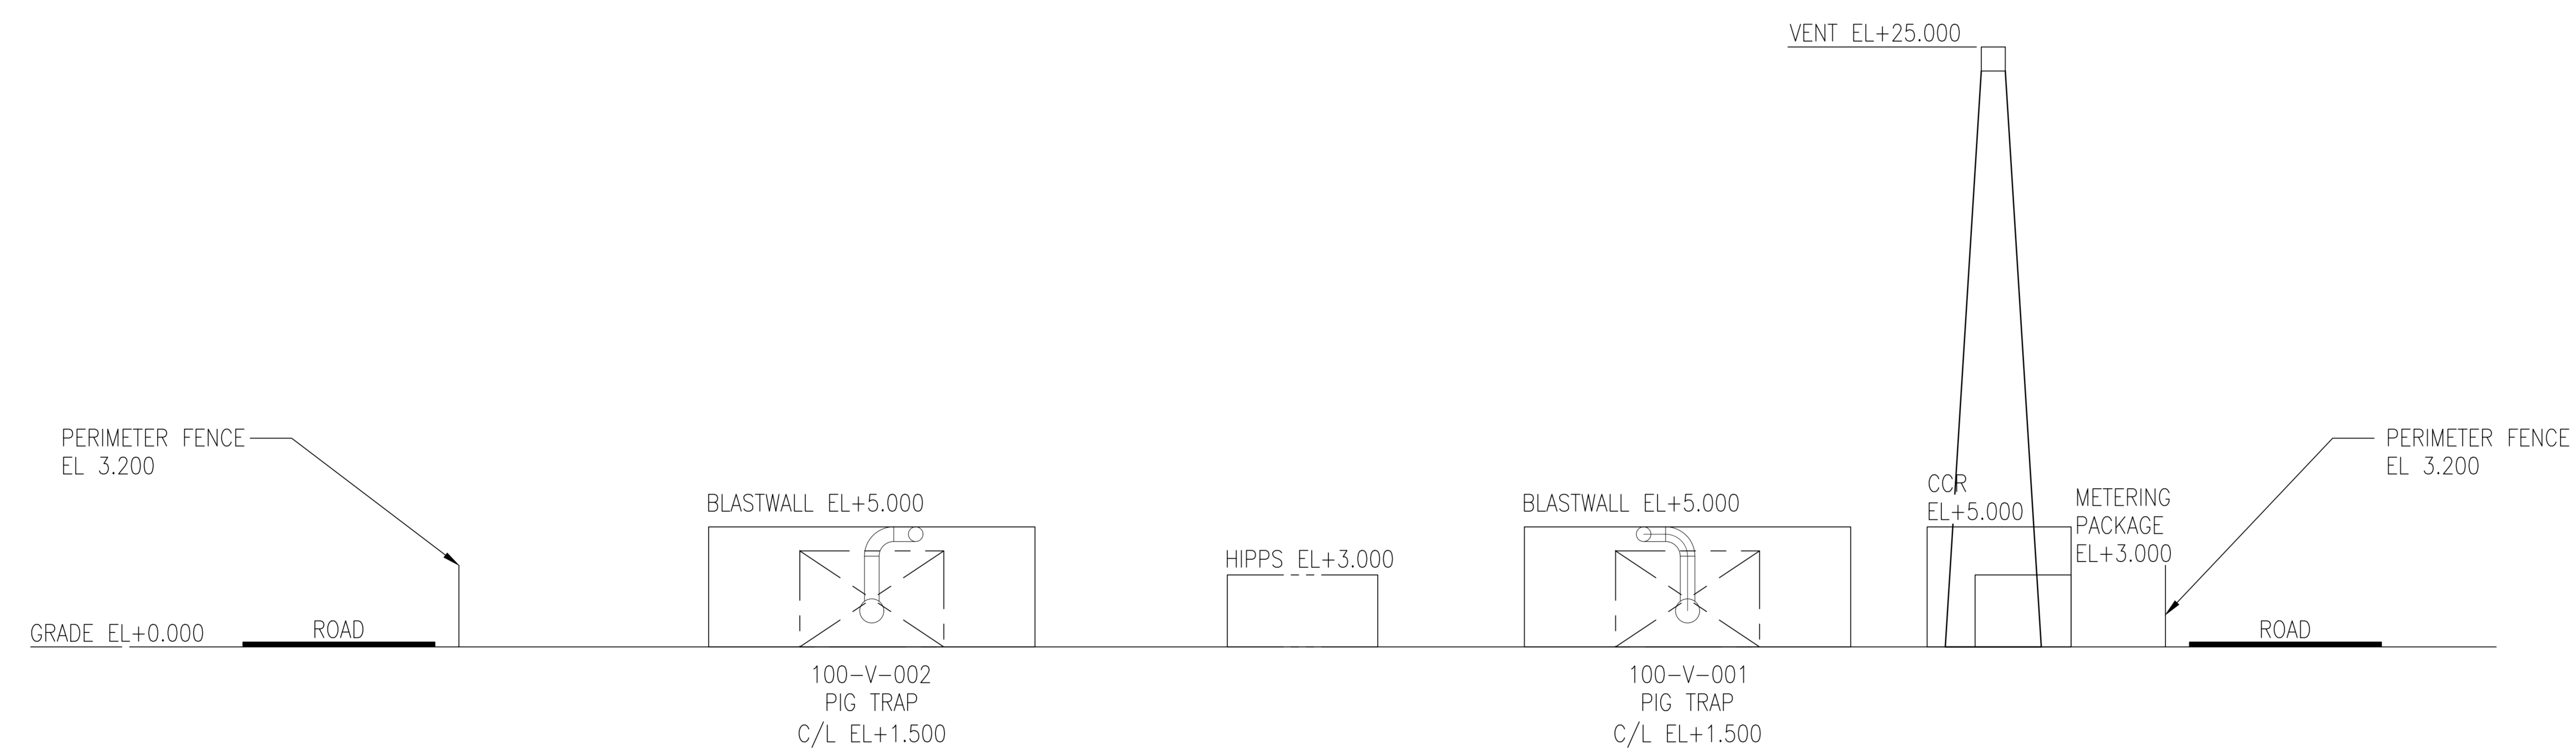ELEVATION LOOKING EAST



REV.	DATE	REVISION DESCRIPTION	ORIG'D	CHK'D	REV'D	APP'D
A2	12/07/2023	ISSUED FOR USE	RM	SG	PH	PH
A1	02/06/2023	ISSUED FOR COMMENT	JB	SG	PH	PH
A0	12/09/2022	ISSUED FOR IDC	JB	SG	PH	PH



SCALE	1:200	ORIGINAL DRAWING SIZE	A0
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PROJECT VIKING CCS PIPELINE FEL-2

TITLE THEDDLETHORPE GAS TERMINAL NORTH & EAST ELEVATIONS

DCO APPLICATION DETAILS:  
VIKING CCS PIPELINE THEDDLETHORPE FACILITIES - ELEVATIONS REGULATION 5.2 (O) APPLICATION DOCUMENT REFERENCE 4.7 SHEET 3 OF 3

CLIENT DRAWING NUMBER: KNT-UKOS-T-TGT-X-EN-30-00003-01 Rev C1  
KENT DRAWING NUMBER: 5211584-215-PI-DWG-002

REV	A2
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